


E LANDSCAPE BOULDER
SCALE: NTS SECTION

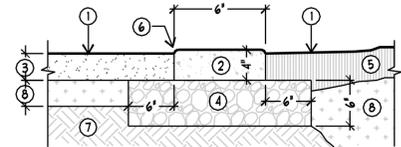


NOTE:
1. FINISH W/ MED. BROOM PERPENDICULAR TO HEADER RUN.
2. EXPANSION JOINTS AT 20' O.C. AND A TOOLED JOINT AT 10' O.C.

D CONCRETE MOW CURB
SCALE: NTS SECTION



- 1 FINISH GRADE
- 2 CONCRETE MOW CURB
- 3 LANDSCAPED AREA
- 4 COMPACTED UNTREATED BASE COURSE
- 5 TURF GRASS
- 6 1/4" RADIUS, TYPICAL
- 7 COMPACTED SUBGRADE
- 8 TOPSOIL

- NOTES:**
- AGGREGATE SHALL BE COMPLETELY ENCASED IN FILTER FABRIC.
 - STONE AGGREGATE SHALL BE PLACED IN LIFTS AND COMPACTED USING PLATE COMPACTORS. THE MAXIMUM LOOSE LIFT THICKNESS SHALL BE 12".
 - FOLLOWING STONE AGGREGATE PLACEMENT, THE GEOTEXTILE MUST BE FOLDED OVER THE TOP TO FORM A 12" MINIMUM OVERLAP.
 - VOIDS SHALL NOT EXIST BETWEEN THE GEOTEXTILE AND THE EXCAVATED SIDES OF WELL.

- 1 TOPSOIL
- 2 COMPACTED SUBGRADE
- 3 1-1/2" CLEAN DRAIN ROCK
- 4 INSTALL PERMEABLE FILTER FABRIC ON TOP AND SIDES OF WELL
- 5 12" NYOPLAST IN-LINE DRAIN WITH INTEGRATED DUCTILE IRON PEDESTRIAN-RATED FRAME AND GRATE, OR APPROVED EQUAL
- 6 12" PERFORATED ADS PIPE
- 7 24" SQUARE STEEL FOOT PLATE

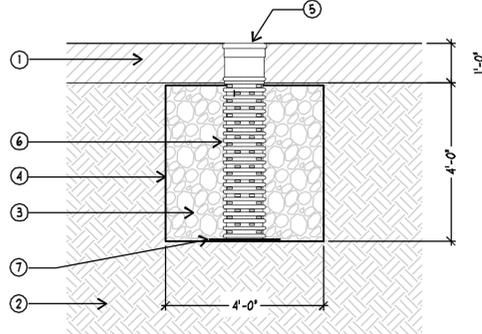


B INFILTRATION WELL
SCALE: NTS SECTION

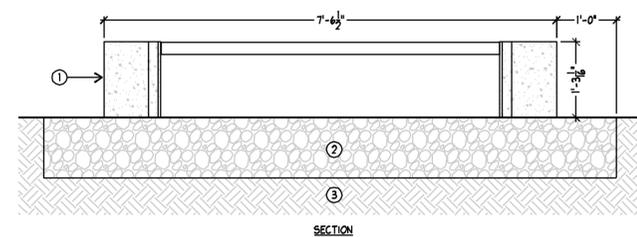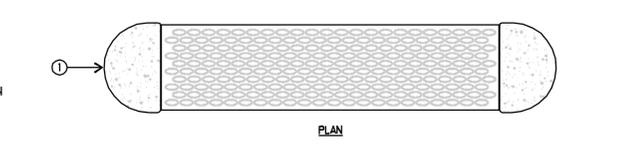

- 1 BENCH- SEE SPECIFICATIONS
- 2 COMPACTED UNTREATED BASE COURSE (12" DEPTH)
- 3 COMPACTED SUBGRADE


NOTE:
1. INSTALLATION TO BE COMPLETED IN ACCORDANCE WITH MANUFACTURER'S SPECIFICATIONS.

A BENCH
SCALE: NTS SECTION

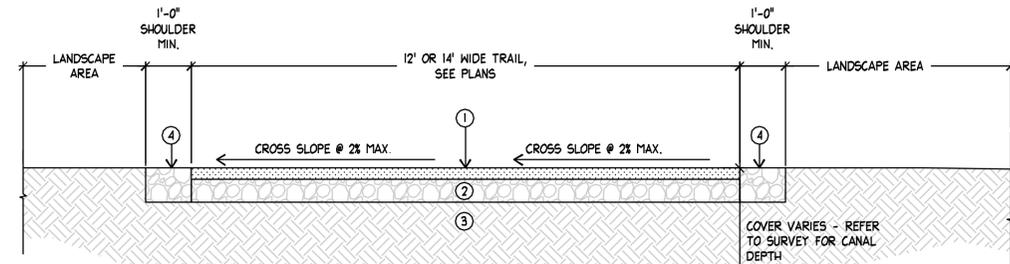





F TYPICAL TRAIL SECTION
SCALE: NTS SECTION

- 1 ASPHALT PAVEMENT, 6" THICK
- 2 6" COMPACTED UNTREATED BASE COURSE
- 3 COMPACTED SUB-GRADE
- 4 COMPACTED UNTREATED BASE COURSE, 12" THICK

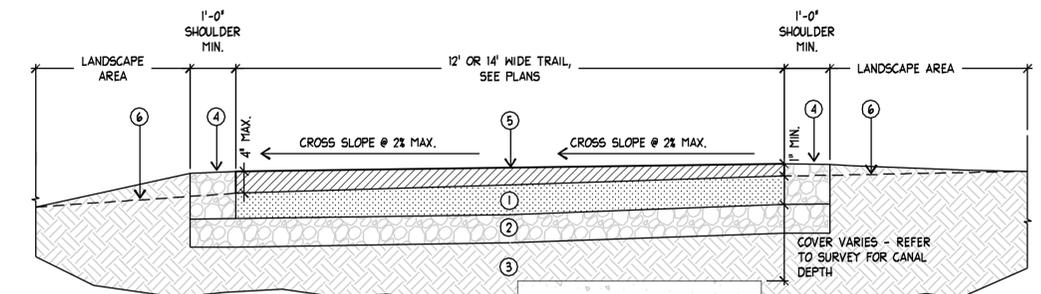

G TYPICAL TRAIL SECTION - VARIABLE THICKNESS
SCALE: NTS SECTION

- 1 EXISTING ASPHALT PAVEMENT
- 2 6" COMPACTED UNTREATED BASE COURSE
- 3 COMPACTED SUB-GRADE
- 4 COMPACTED UNTREATED BASE COURSE, 12" THICK
- 5 CRACK SEAL & TOP COAT WITH 1/2" ASPHALT MIX (VARIABLE THICKNESS, REFER TO GRADING PLANS)
- 6 EXISTING FINISH GRADE

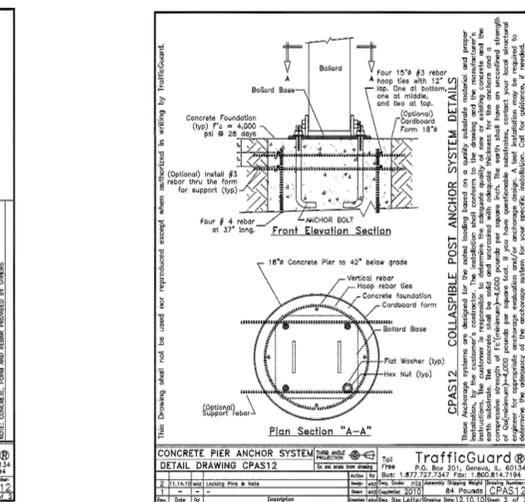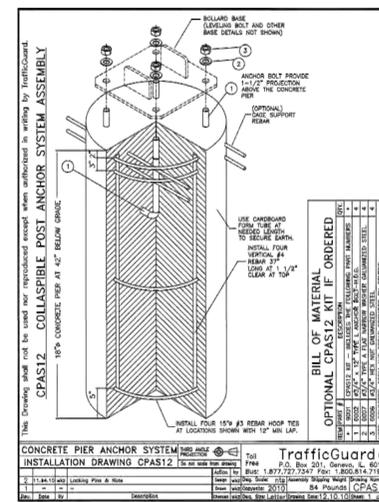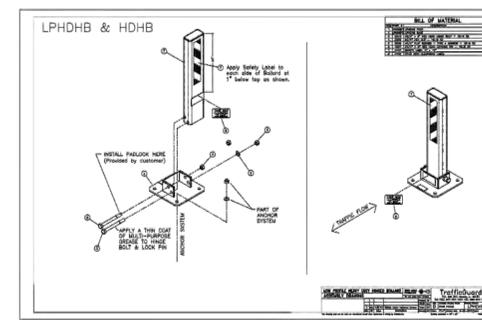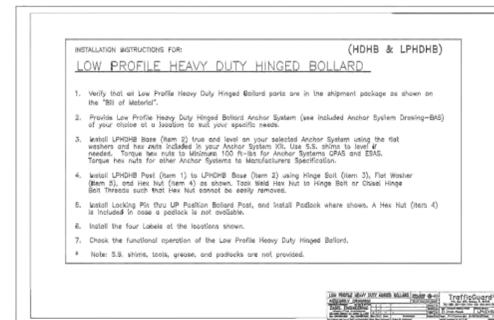

C COLLAPSIBLE BOLLARD; LOW-PROFILE, HEAVY-DUTY, HINGED
SCALE: NT

NOTES/ISOMETRIC/SECTION


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PROJECT IDENTIFICATION:

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2350 SOUTH TO
800 SOUTH**

PROJECT OWNER:

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SHEET TITLE:

**LANDSCAPE SITE
DETAILS**

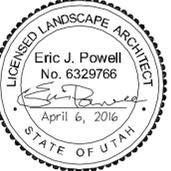SHEET IDENTIFIER:

LS501

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